


5/16/2019 9:49 AM - macield - C:\Projects\Eversource\Line 373\Plan and Profile Drawings\Cr...037343901.dwg - LOCATION MAP ES VER: 12/2016

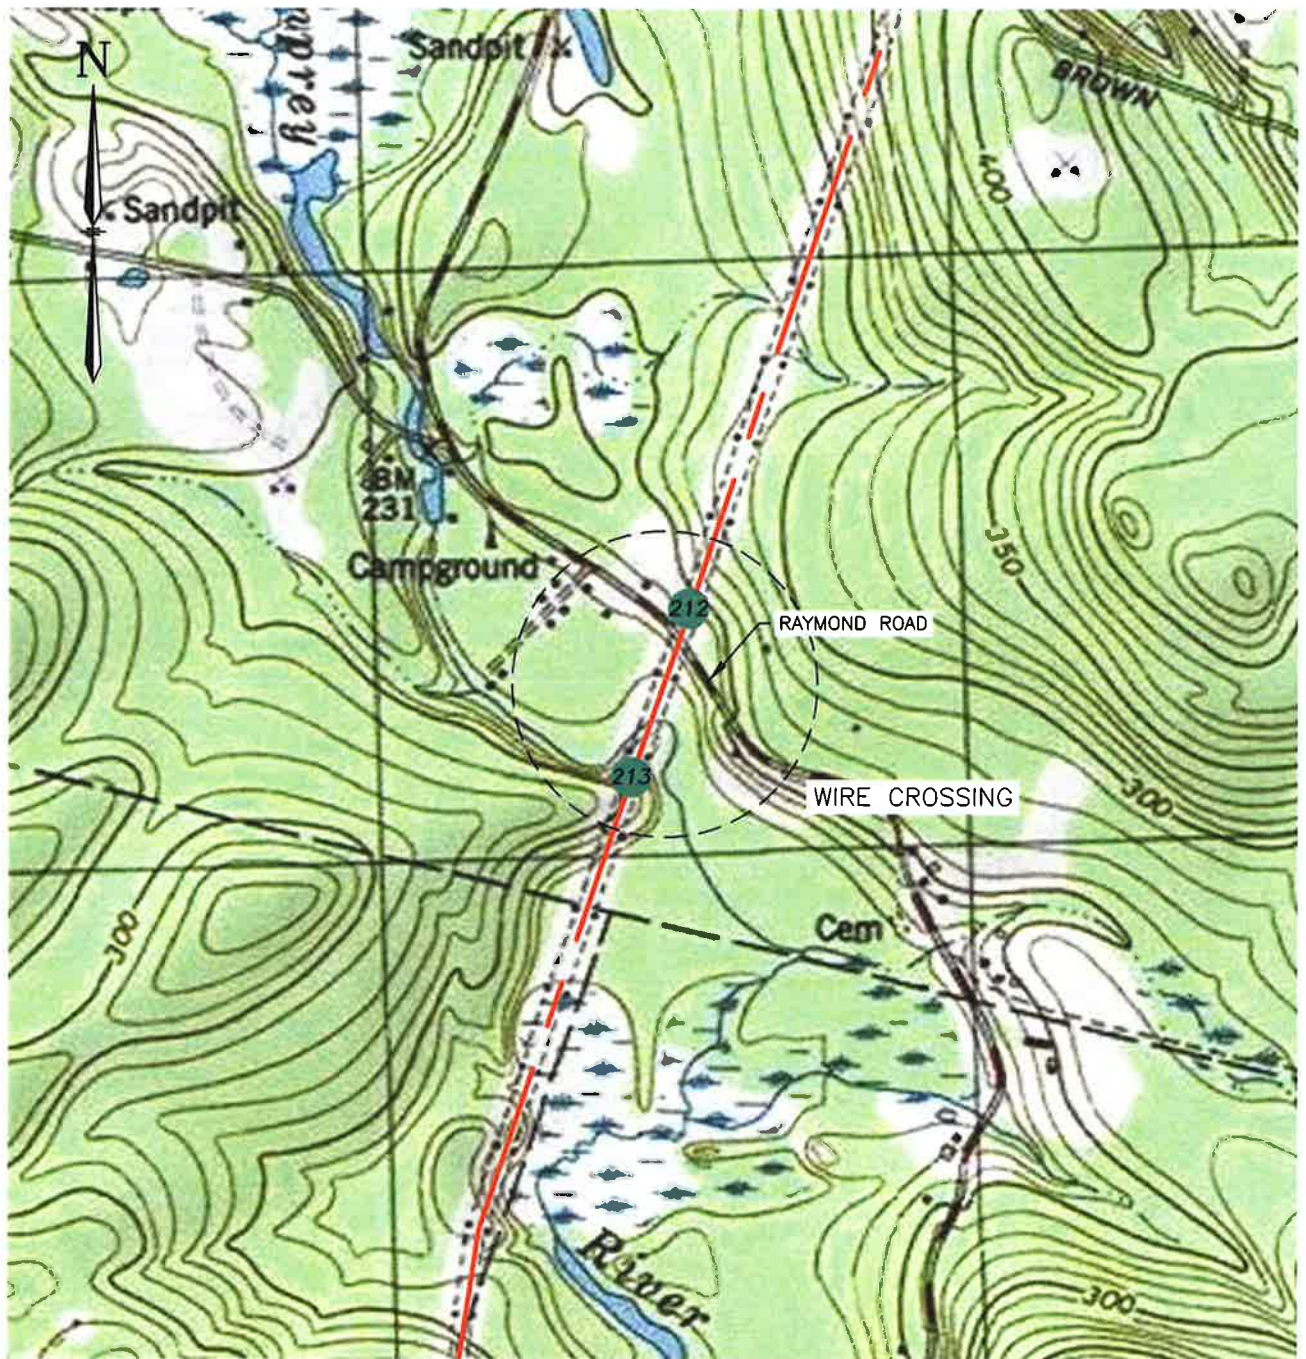

**LOCATION PLAN**

**EXHIBIT 1**

**LEGEND:**

373 LINE ———  
 PROPOSED 373 STR 212

**EVERSOURCE ENERGY**

LINE 373 345kV TRANSMISSION  
 LAMPREY RIVER WATERBODY CROSSING  
 DEERFIELD, NH  
 EXHIBIT #1


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DRAWN	DGM
ENGINEER	RSN
CHECKED	DWW
APPROVED	KLM
DATE	4/23/19

DWG REV	EPN/DESCRIPTION	CONT/PE#	DATE	DRN	CHKD	APPR
0	SUBMITTED FOR REVIEW		4/23/19	DGM	RSN	



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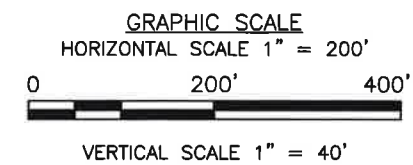
**PROFILE VIEW**



**PLAN VIEW**

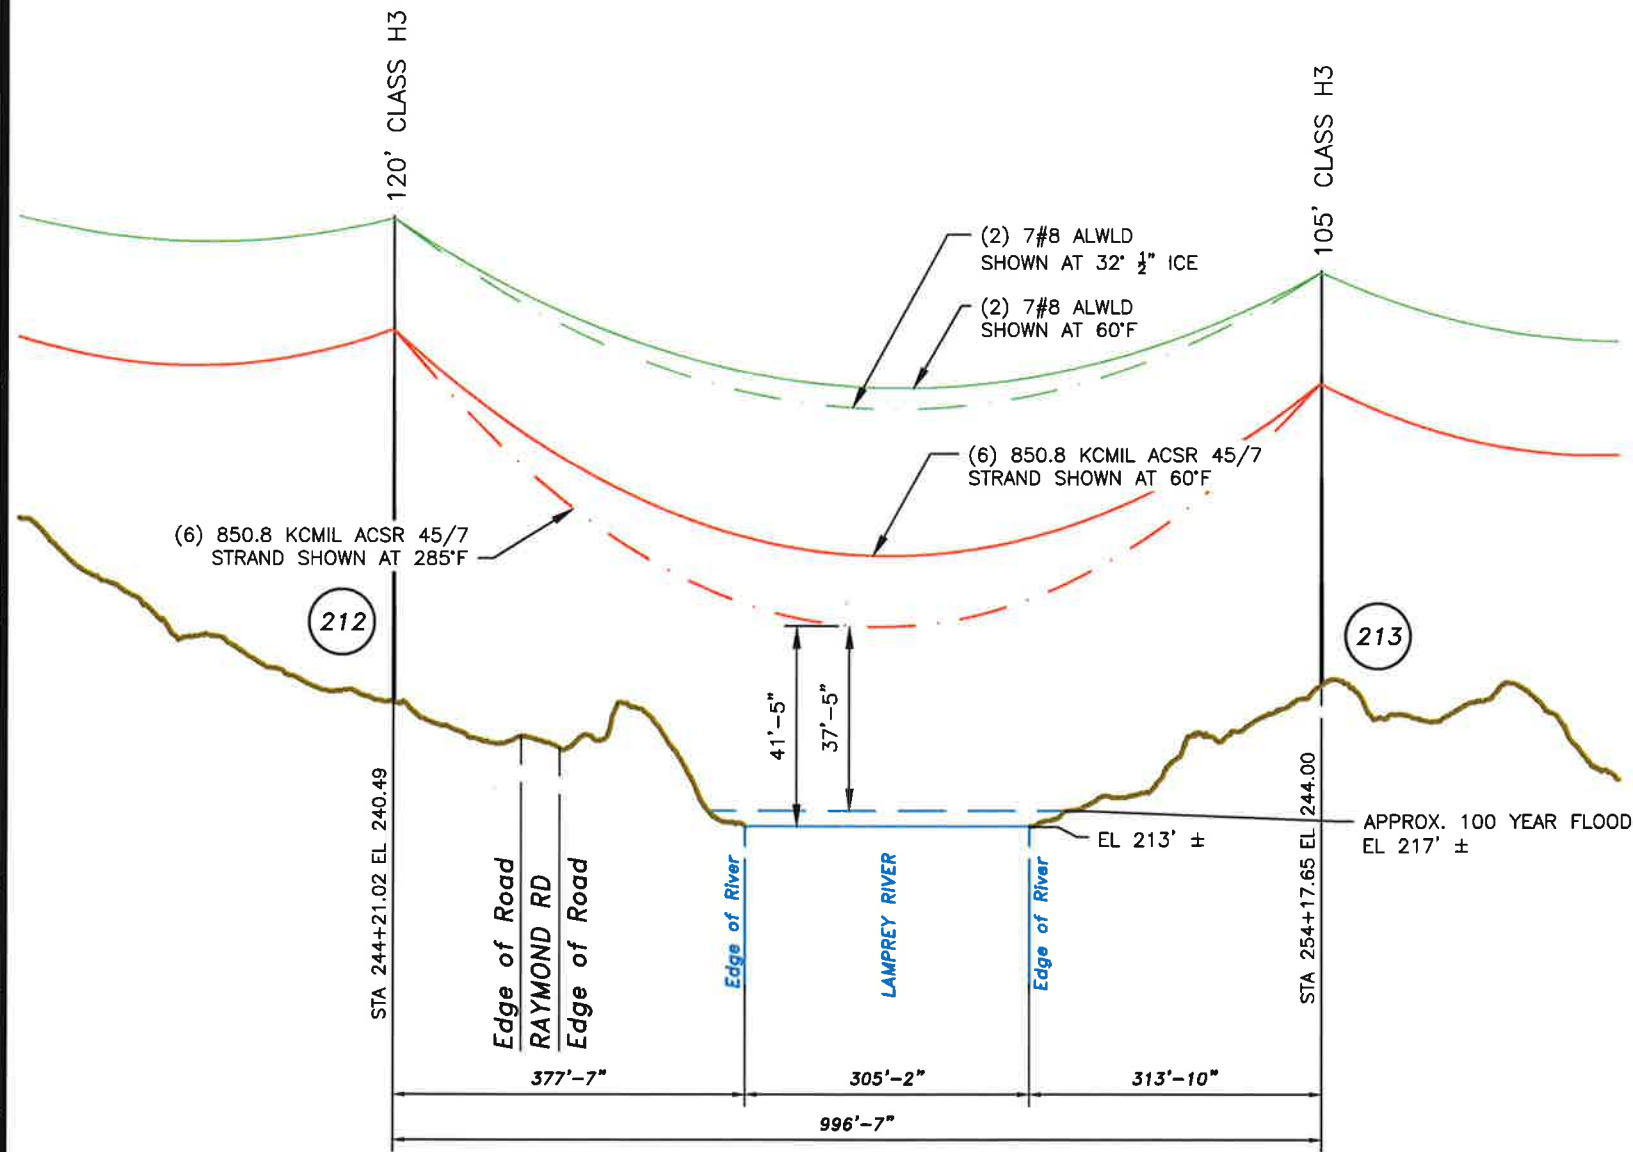**NOTES:**

- GROUND ELEVATION PROFILE DETERMINED USING INFORMATION FROM LIDAR SURVEY IN LATEST PLS-CADD MODEL.
- VERTICAL DATUM IS NAVD88 IN FEET.
- ONLY LOWEST CONDUCTOR PHASE SHOWN FOR CLARITY.

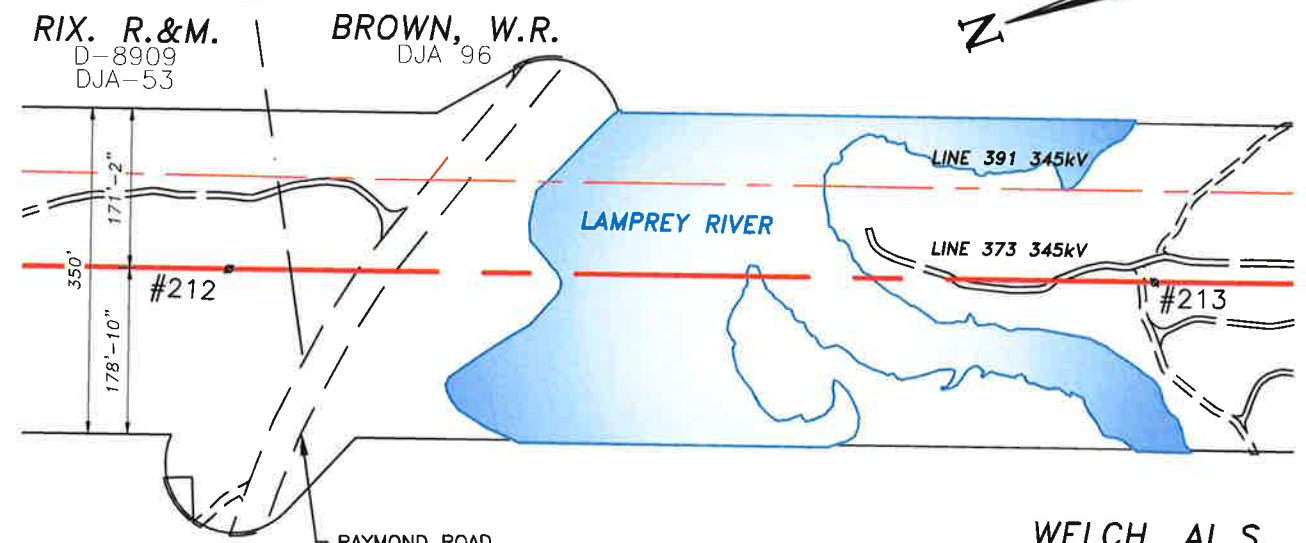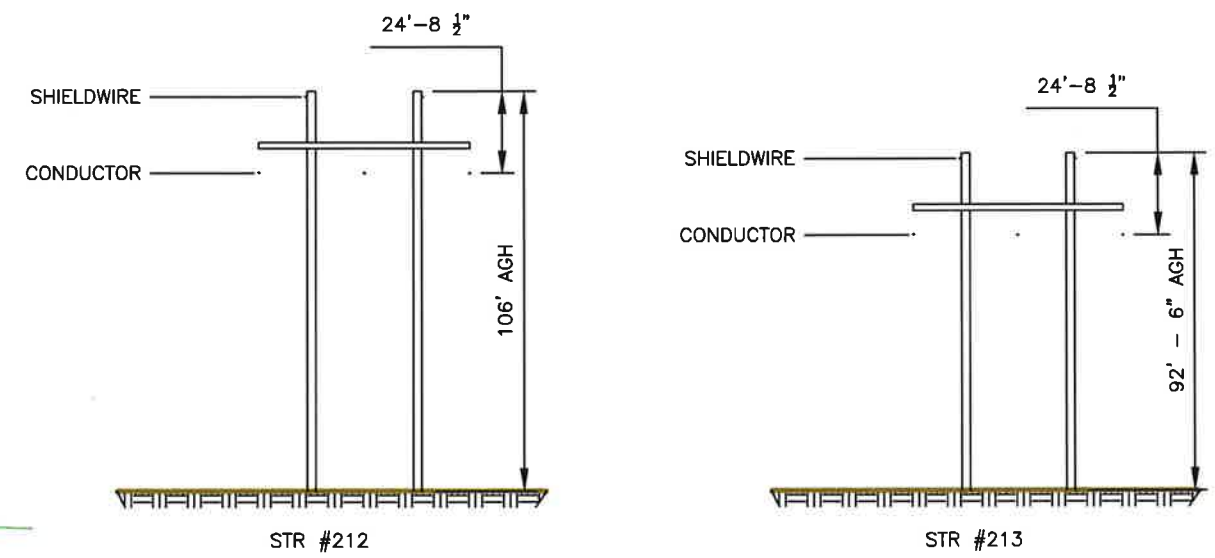

**STRUCTURE LOCATION:**

STR. #212 - LAT. = 43° 5'4.74"N  
 LONG. = 71°13'43.76"W  
 STR. #213 - LAT. = 43° 4'55.44"N  
 LONG. = 71°13'48.15"W

**PROFILE LEGEND:**

- CONDUCTOR**
- SHOWN AT 60°F
  - - - SHOWN AT 285°F (MAX SAG)
- SHIELDWIRE**
- SHOWN AT 60°F
  - - - SHOWN AT 32' 1/2" ICE (MAX SAG)

**PLAN LEGEND:**

- ∅ PROPOSED STRUCTURE
- LINE 373
- - - LINE 391
- MAJOR ROAD

DWG REV	EPN/DESCRIPTION	CONT/PE#	DATE	DRN	CHKD	APPR
0	SUBMITTED FOR REVIEW		4/23/19	DGM	RSN	

**EXHIBIT 2**

CONDUCTOR (6) 850.8 KCMIL ACSR 45/7 STRAND INSTALLED • 7,500 LBS NESC HEAVY INITIAL  
 SHIELDWIRE (2) 7#8 ALWLD INSTALLED • 4,400 LBS NESC HEAVY INITIAL



LINE 373 345 kV TRANSMISSION  
 LAMPREY RIVER WATERBODY CROSSING  
 DEERFIELD, NH  
 EXHIBIT #2

T	0
DRAWN	DGM
ENGINEER	RSN
CHECKED	DWW
APPROVED	KLM
DATE	4/23/19

SCALE AS SHOWN	FILE: 037343901.DWG	DRAWING NO. 037343901
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